



NORTH ELEVATION - PROPOSED

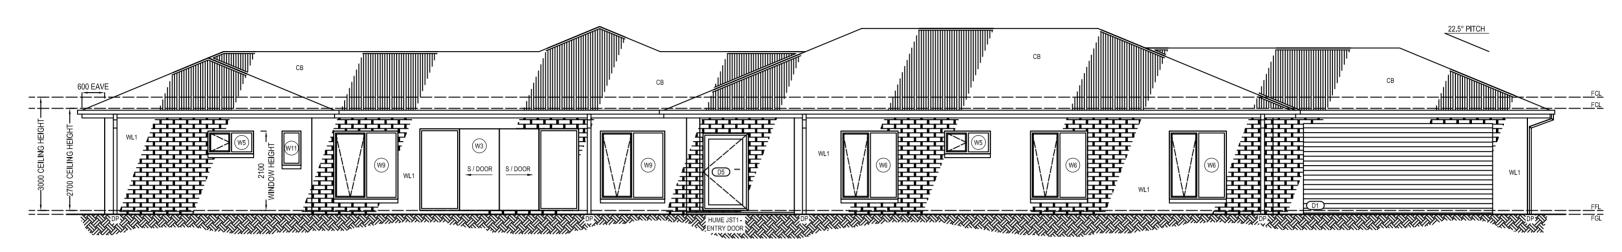

SOUTH ELEVATION - PROPOSED

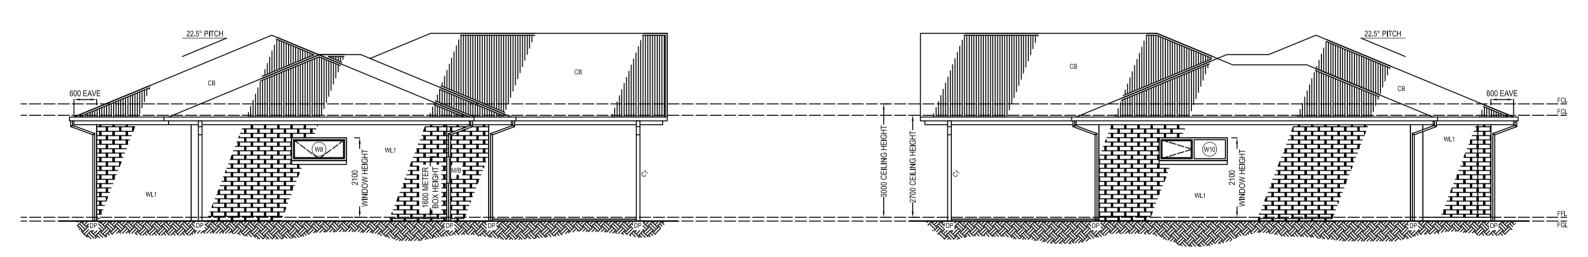

EAST ELEVATION - PROPOSED

WEST ELEVATION - PROPOSED

Roof

ROOF BRACING: 20mm PERFORATED STRAP FIXED DIAGONALLY OVER TRUSSES. REFER TO ENGINEER'S
COMPUTATIONS FOR TIE-DOWN REQUIREMENTS

"SCISSOR" TRUSS ROOF STRUCTURE TO 3m HIGH FAMILY / MEALS / KITCHEN AREA (REFER TO ROOF PLAN)

CEILING INSULATION KNAUF G/WOOL R7.0 EARTHWOOL

SLOTTED QUAD GUTTERING FIXED TO 190 x 32 (NOMINAL) COLORBOND METAL FASCIAS. FALL 1:400 TO SELECTED DOWNPIPES

PROVIDE SISALATION TO ROOF AREA FOIL SISLATION PAPER DRAPED OVER BATTENS 10mm PLASTERBOARD CEILING LINING PROVIDE SARKING TO UNDERSIDE OF ROOF BATTENS COLORBOND ROOF SHEETING CUSTOM ORB TO RESIDENCE @ 22.5°. PROFILE AND COLOUR TO CLIENT'S SELECTION. INSTALL AS PER MANUFACTURER'S SPECIFICATIONS. CEILING INSULATION AS REQUIRED.

FASCIA AND FLASHINGS MOUNTED 600mm FROM EXTERIOR CLADDING

METAL ROOF BATTENS AT 900 CENTERS GRADED TO CREATE MIN 22.5° FALL ABOVE RESIDENCE

TIMBER ROOF TRUSSES BY A LICENSED TRUSS MANUFACTURER TO AUSTRALIAN STANDARDS. TIMBER FRAME RAFTERS & TRUSSES @ 900 CENTERS

SELECTED COLORBOND FASCIA & EAVES GUTTER

GABLE END OF ALFRRESCO CONSISTS OF "SCISSOR" TRUSS ROOF STRUCTURE THROUGHOUT (REFER TO NORTH ELEVATION AND ROOF PLAN)

Walls

FRAMING TO COMPLY WITH AS1684

WALL INSULATION KNAUF G/WOOL R2.5 EARTHWOOL

WALL FRAMING: 90mm TIMBER WALL FRAMING @ 450 CENTRES OR SIMILAR TO MANUF. SPECS

EXTERNAL EXTERIOR CLADDING BRICK VENEER

10mm RE PLASTERBOARD INTERNAL LININGS -"6mm VILLABOARD" LININGS TO WET AREA

Windows / Doors

ALUMINIUM GLAZED JOINERY INSTALLED TO MANUFACTURER'S SPECIFICATIONS AND COMPLY WITH PART 3.6 OF THE CURRENT NCC

THROUGHOUT WITH SECURITY SCREENS
(SITE RATING N4 (S=600, U=1400, WPR=150pa) FLYSCREENS TO ALL OPENING SASHES

DOUBLE GLAZED POWDERCOAT SLIDING DOOR WITH DECAL. AS PER NCC 3.6.4. AND AS1288

HARDIPLANK INFILLS ABOVE WINDOWS AND EXTERNAL DOORS

Porch

350x350 BRICK PIER

POWDER COATED BOXSPAN 150 x 50 -16 GALVABOND VERANDAH BEAMS

Flooring

STRUCTURAL FLOORING TO MANUF SPECIFICATIONS

CONCRETE FLOOR SLAB AND FOOTING DESIGN TO STRUCTURAL ENGINEER'S SPECIFICATIONS

REFER ENGINEERS' DESIGN FOR

TOP OF METER BOX 2000mm MAX ABOVE FINISHED GROUND LINE.

WINDOWS TO BE ALUMINIUM, SASHE AS INDICATED.

SLIDING DOORS TO BE ALUMINIUM, SLIDERS AS INDICATED. BRICKWORK OVER EXTERNAL DOORS AND WINDOWS WHERE SHOWN.

 FLY SCREENS TO ALL OPENABLE SASHES. WINDOW LOCKS TO ALL OPENABLE SASHES.

BARRIER DOORS TO LIVING, LAUNDRY, SLIDING DOOR & FRONT ENTRY DOOR.

COLORBOND ROOF SHEETING COLORBOND DOWNPIPE. CONNECT TO EXISTING STORMWATER LINE FINISHED CEILING LEVEL FINISHED FLOOR LEVEL

ELEVATION LEGEND

MB W00 METER BOX WINDOW NUMBER, REFER TO SCHEDULE

DOOR NUMBER, REFER TO SCHEDULE

WALL TYPE LEGEND WL1 BRICK VENEER



IMPORTANT NOTES:

Do no scale from drawings. All dimensions to be checked on site before commencement or work. An developence to de drought to the attention or the Designer/Design Manager. Larger scale drawings and written dimensions take preference, Drawing to be read in conjunction with all project documents including but not limited to architectural drawings, specifications, schedules and all consultants drawings, reports, specifications and schedules.

This drawings is copyright and the property of the author and must not be retained, copied or used without the express authority of Interkit Australia.

Preliminary Drawing

No.	Description	Date	Ву
A	PRELIMINARY DRAWINGS	22.8.2022	MJA

CLIENT:

James & Angelica Smith Lot 48, 2826 Kingstown Rd, Kingstown, NSW, 2358

PROJECT NAME:

Proposed New Residence

DRAWING TITLE

Proposed Plan - Elevations

J O			
	SCALE 1:100 @ A2	PROJECT NO. 400	CHECK BY Bob
	DATE 22.08.2022	DRAWN BY MJA	DRAWING NO. CD-05

